





SCHEDULE OF SPECIAL WINDOWS & DOORS

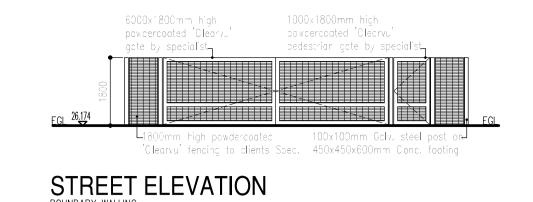

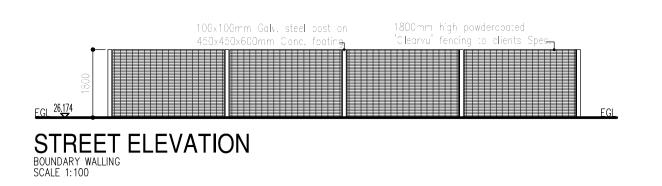



PROVIDE A TELKON CONNECTION LAID TO SABS 950/1969. WATER METER AND CONNECTION PIPE TO BE MIN. 19mm ID.

- SUPPLY AND FIT SINGLE PHASE ELECTRICAL CONN. FROW COUNCIL. 4. NO PLUMBING PIPES TO BE VISIBLE FROM THE STREET.
- EXTERNAL STEPS MAX. RISERS 150mm, MIN. TREADS 300mm. . EXPANSION JOINTS TO BE PROVIDED TO BOUNDARY WALLS AT MAX.
- 5000mm CENTERS. (where applicable) ALL CAVITIES SHOULD BE KERT CLEAN FROM EXCESS CONCRETE &
- B. WEEP-OLES TO BE WIN. 1200mm ABOVE NGL. LIGHT SWITCHES TO BE WIN. 400mm ABOVE FE
-). WALL SOCKETS TO BE MIN. 400mm ABOVE FFL. . CELING MOUNTED POWER SOCKETS TO BE PROVIDED TO U/S OF CELING.
- . W/M & D/W WASTE TO BE MIN. 600mm ABOVE FFL. 3. SUPPLY AND WASTE TO W/M & D/W TO BE IN 90mm DEEP RECESS
- 4. NO PORTION OF BUILDING TO EXTEND OVER THE SITE BOUNDARY. 5. ALL TIMBER BUILT INTO BRICKWORK TO BE WRAPPED IN DPC. 6. ALL WATERPROOFING TO BE DONE BY SPECIALIST.

RCOF CONSTRUCTION: (Refuse Room) 'BR' GA V. STEFL CORRUGATED LONG SPAN SINGLE ENGTH ROCE SHEETING AT 3dec. PICCH, ON 76x50mm SA PINE TIMBER PURLINS AT 1000mm NTERS ON 228x50mm SA PINE TIMBER RAFTERS AT 760mm CENTERS FIXED TO BRICKWALL WITH GALV. STEEL TECC' BRACKETS. GALV. STEEL HEADWALL AND SIDEWALL FLASHING. ALL ROOFING ELEMENTS TO BE DESIGNED BY SPECIALIST. WATERPROOFING TO BE DONE BY SPECIALIST. BOXGUTTER (See DelcT 2).

TO BE CARRIED OUT IN STRICT ACCORDANCE WITH LOCAL

JT-CRITY REGULATIONS AND BYE-LAWS. CONTRACTOR MUST CHECK ALL

EVELS, DIMENSIONS AND WALL HEIGHTS AND ANGLES ON SITE BEFORE

RRORS IN LEVELS, -FIGHTS, DIMENSIONS OR WALL ANGLES WILL BE THE

COMMENCEMENT OF ANY WORK. ANY SUCH OVERSIGHT RESULTING IN

RESPONSIBILITY OF THE CONTRACTOR. WRITTEN DIMENSIONS SHOULD BE

JSED IN PREFERENCE TO SCALING THE DRAWINGS. ALL WORK TO BE

CARRIED OUT IN STRICT ACCORDANCE WITH THE DRAWINGS. RESULT IN ERRORS OR DISCREPANCIES ON PLAN, THE ARCHITECT SHOULD BE VERIFIED

CONNECTION POINT AND LEVELS TO BE VERIFIED BY THE PLUMBING.

IMMEDIATELY BEFORE COMMENCEMENT OF ANY WORK, DRAINAGE

CONTRACTOR BEFORE COMMENCEMENT OF ANY WORK.

ROOF CONSTRUCTION : (Main Structure) 'IBR' GALV, STEEL CORRÙGATED LONG ŚPAN SINGLE LENGTH ROOF SHEETING 10dec. PFCH, ON 100x50x20mm GALV. STEEL CHANNEL ON GLAV. STEEL ORTAL FRAME TÓ ENGINEERS SPEC. ON GALV. STEEL I—BEAMS TO ENGINEERS SPEC. 150mm SABS APPROVED ROOF INSULATION TO BE ROVIDED. ALL ROOFING TO BE DESIGNED BY SPECIALIST. WATERPROOFING TO BE DONE BY SPECIALIST.

NDERSIDE OF CONCRETE SLABS TO BE SKIMMED AND PAINTED. 6.5mm SKIMMED RHINOBOARD SUSPENDED CEILINGS TO MANUFACTURER SPEC. FIXED TO UNDERSIDE OF GALV. STEEL PORTAL FRAME (to Monuf. spec.). OCX600mm SA PINE TIMBER TRAPDOOR TO BE PROVIDED IN CEILING. (As er plan).

RAINWATER GOODS

NOTES

50x150mm SEEVLESS ALUMINIUM SQUARE GUTTERS AND 150x150mm ALUMINIUM DOWNPIPE TO DISCHARGE INTO SUMP AND TAKEN TO ROAD WITH VC STORMWATER PIPE. 200x100mm ALUMINIUM SEEMLESS BOXGUTTER ND 75mm DIA. ALJMINIJM DOWNPIPE TO REFUSE ROOM. ALL STORMWATER) BE CHANNELED TO ROAD. ALL PAVED AREAS TO BE GRADED TO THE

FLOOR CONSTRUCTION:

GROUND STOREY - SABS APPROVED MOULDED SKIRTING (to be installed by specialist) ON SPECIFIED FLOOR COVERING (to Client's spec) CN 25mm SCREED ON 100mm CONCRETE SURFACE BED ON 275mm DPM ON 50mm CLEAN SAND BLINDING ON WELL COMPACTED EARTHFILL. WATERPROOFING

O BE DONE BY SPECIALIST. FIRST STOREY - SABS APPROVED MOU DED SKIRTING (to be installed by specialist) ON SPECIFIED FLOOR COVERING (to Client's spec) ON 25mm SCREED ON CONCRETE SIAB (to Eng. spec). WATERPROOFING TO BE DONE BY SPECIALIST.

WALL CONSTRUCTION 190mm - BLOCK WALLS EXTERNALLY ON 750x250mm CONCRETE STRIP CUNDATIONS. 90mm BLOCK WALLS INTERNALLY ON 750x250mm CONCRETE STRIP FOUNDATIONS. 00mm DRYWALL PARTITION INTERNALLY ON CONCRETE SLAB.


L CAVITIES TO BE CLOSED WIN. 3 COURSES BELOW WALL PLATES. OOP-IRON STRAPS FOR FIXING ROOF TO GO THROUGH CLOSURE AND TO OCATE 7 TO 10 COURSES BELOW WALL PLATE LEVEL ALTERNATIVELY.

WINDOWS AND DOORS : ALL WINDOWS AND SLIDING GEAR EX. WISPECO CATALOGUE OR EQUAL AND PPROVED. ALL DOORS EX. RJTHERFORD CATALOGUE OR EQUAL AND APPROVED. IGHTING AND VENTUATION TO COMPLY WITH LOCA AJT-ORITY EQUIREMENTS. DPC TO BE WRAPPED AROUND ALL WINDOW AND DOOR

O BE LAID TO MANUFACTURER'S SPECIFICATION TO ALL OPENINGS

OPENINGS < 3000mm to have Min. 4 courses brickwork with BRICKFORCE TO EACH COURSE.

ALL GLAZING TO COMPLY WITH PART N OF SANS 10400. ALL GLAZING AREAS Exceeding 1m² or less than 500mm above FFL to be 6mm safety

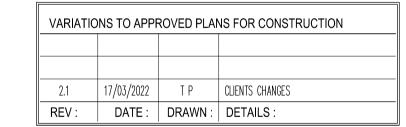


	<u> </u>		
DRAWN:	LA	BUILDIN	G AREAS
DESIGNER:	Fron	SITE AREA BLOCK A BLOCK B BLOCK C	3052sq/r 537,0sq/r 1296,0sq/r 696,0sq/r
	Y	REFUSE ROOM	12,0sq/r
CLIENT:		TOTAL	2541,0sq/n

PROJECT:


DRAWING:


COUNCIL DRAWINGS

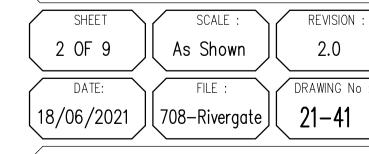



PO BOX 50456 WEST BEACH CELL:082 927 7735 FAX: 086 694 1667 E-MAIL: les@ladesign.co.za SACAP Pr. No. ST1288



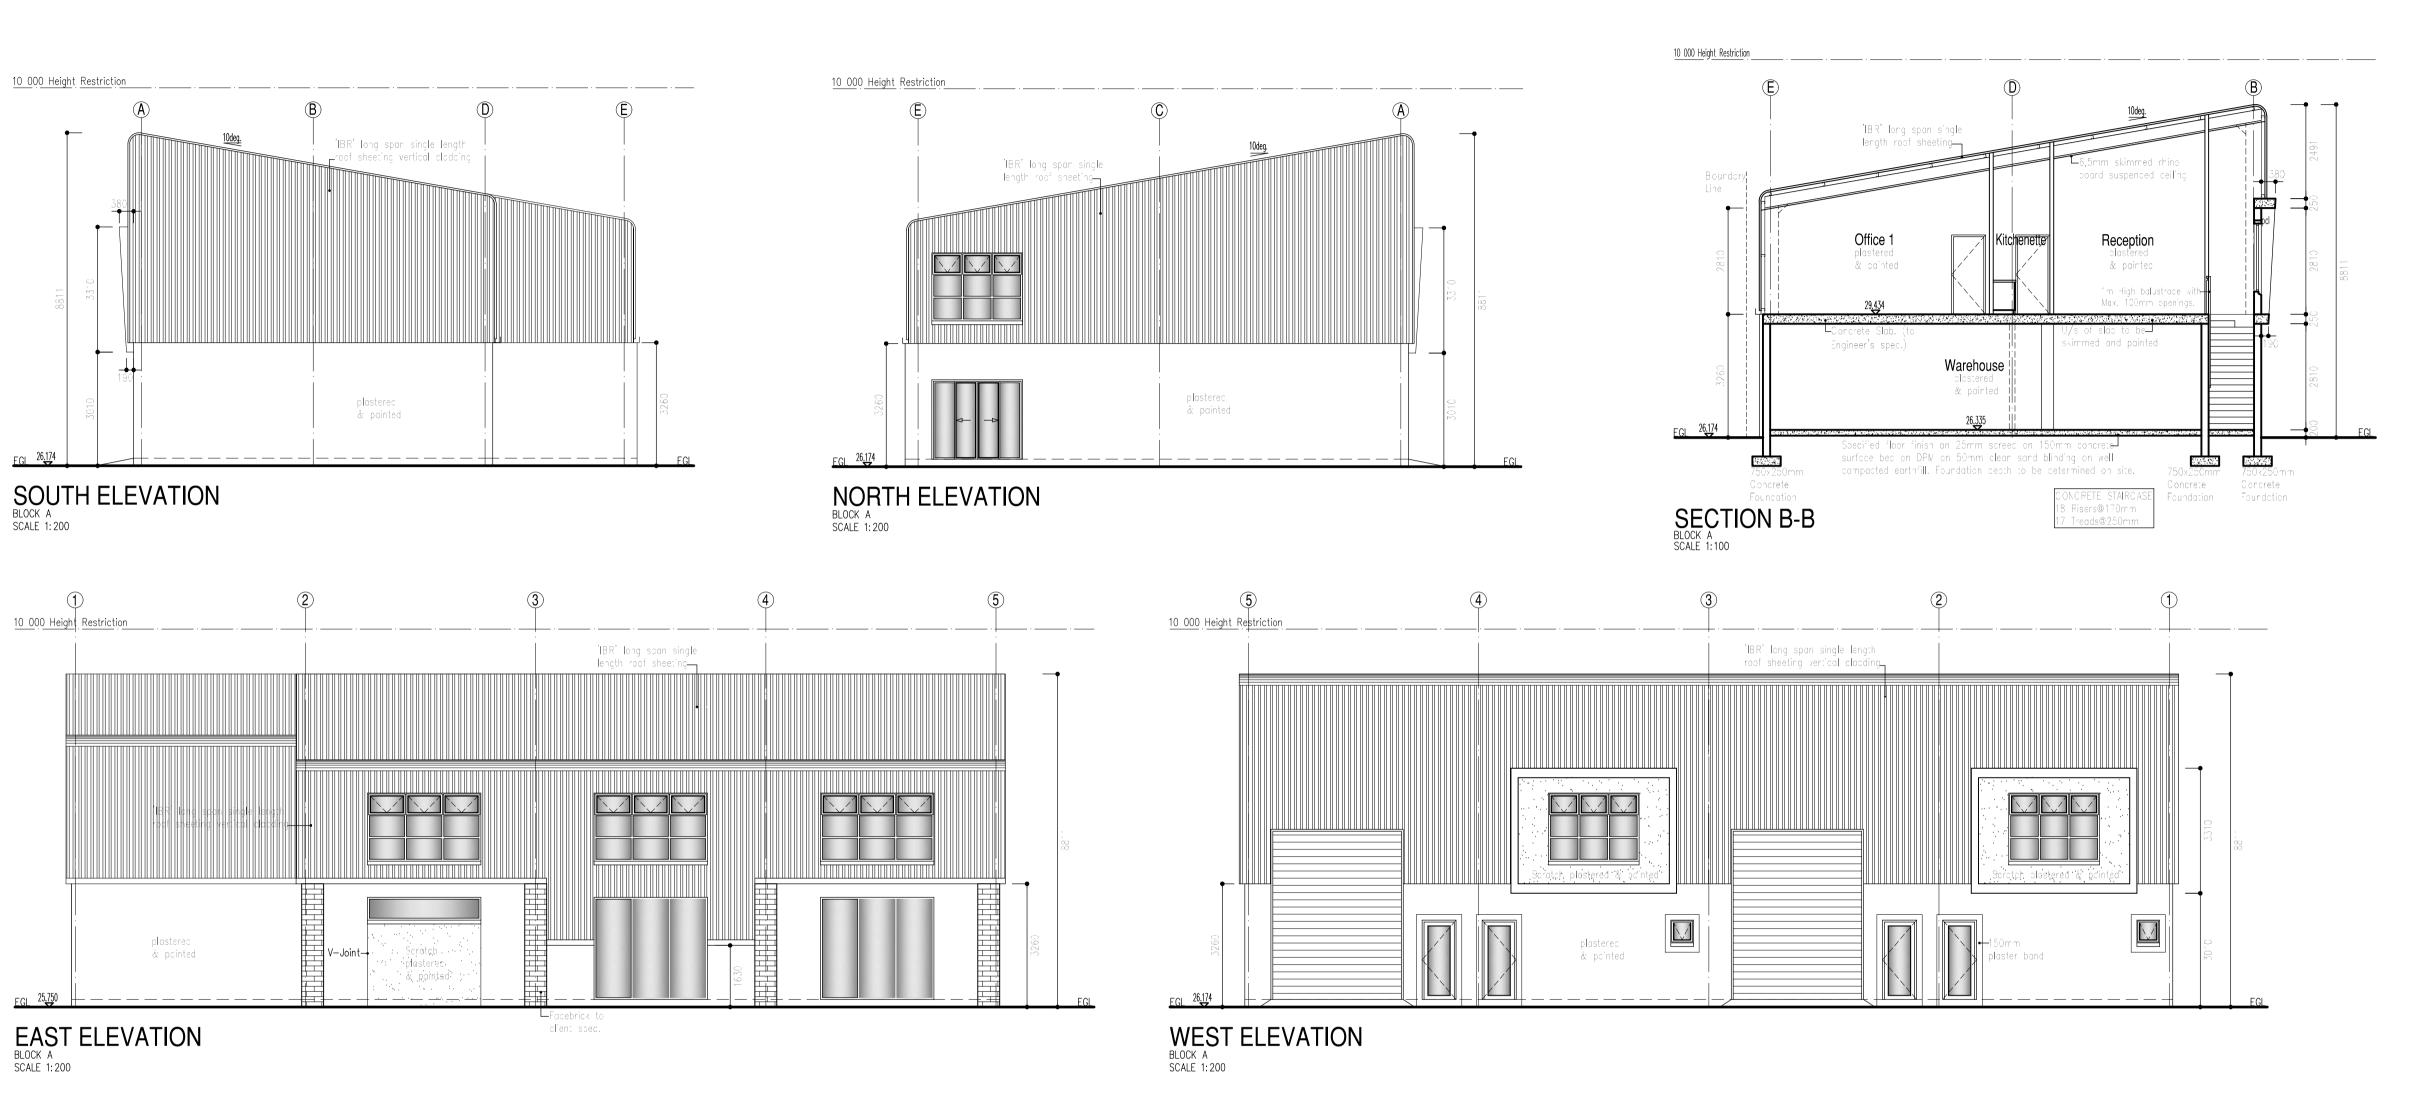


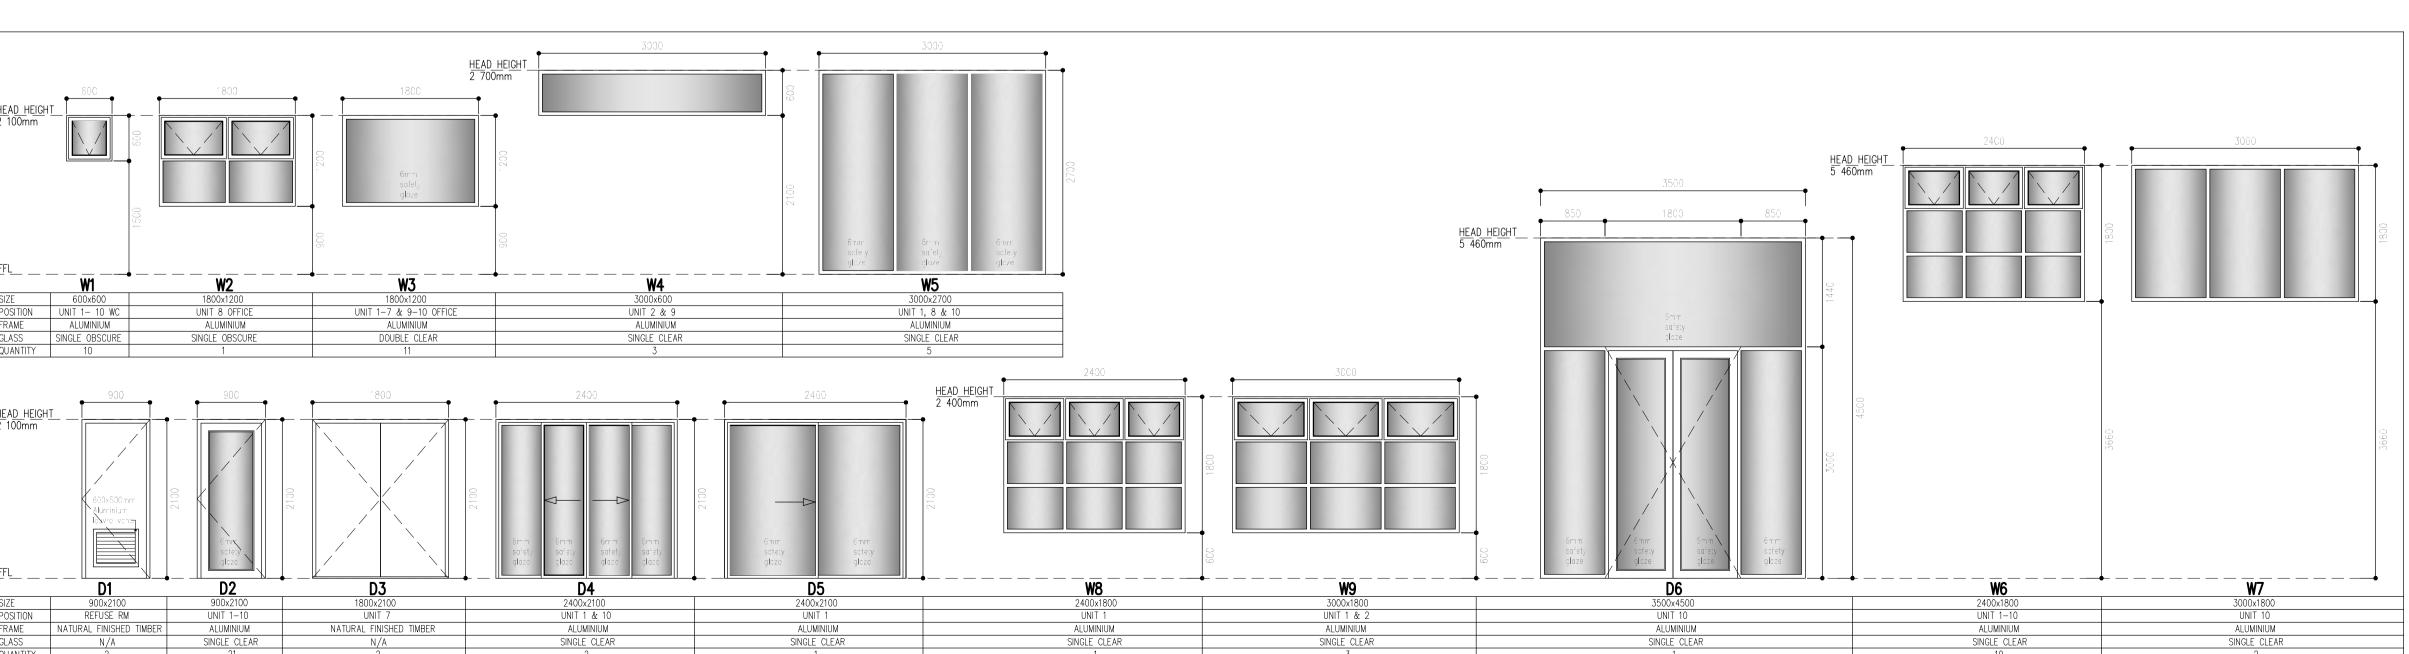

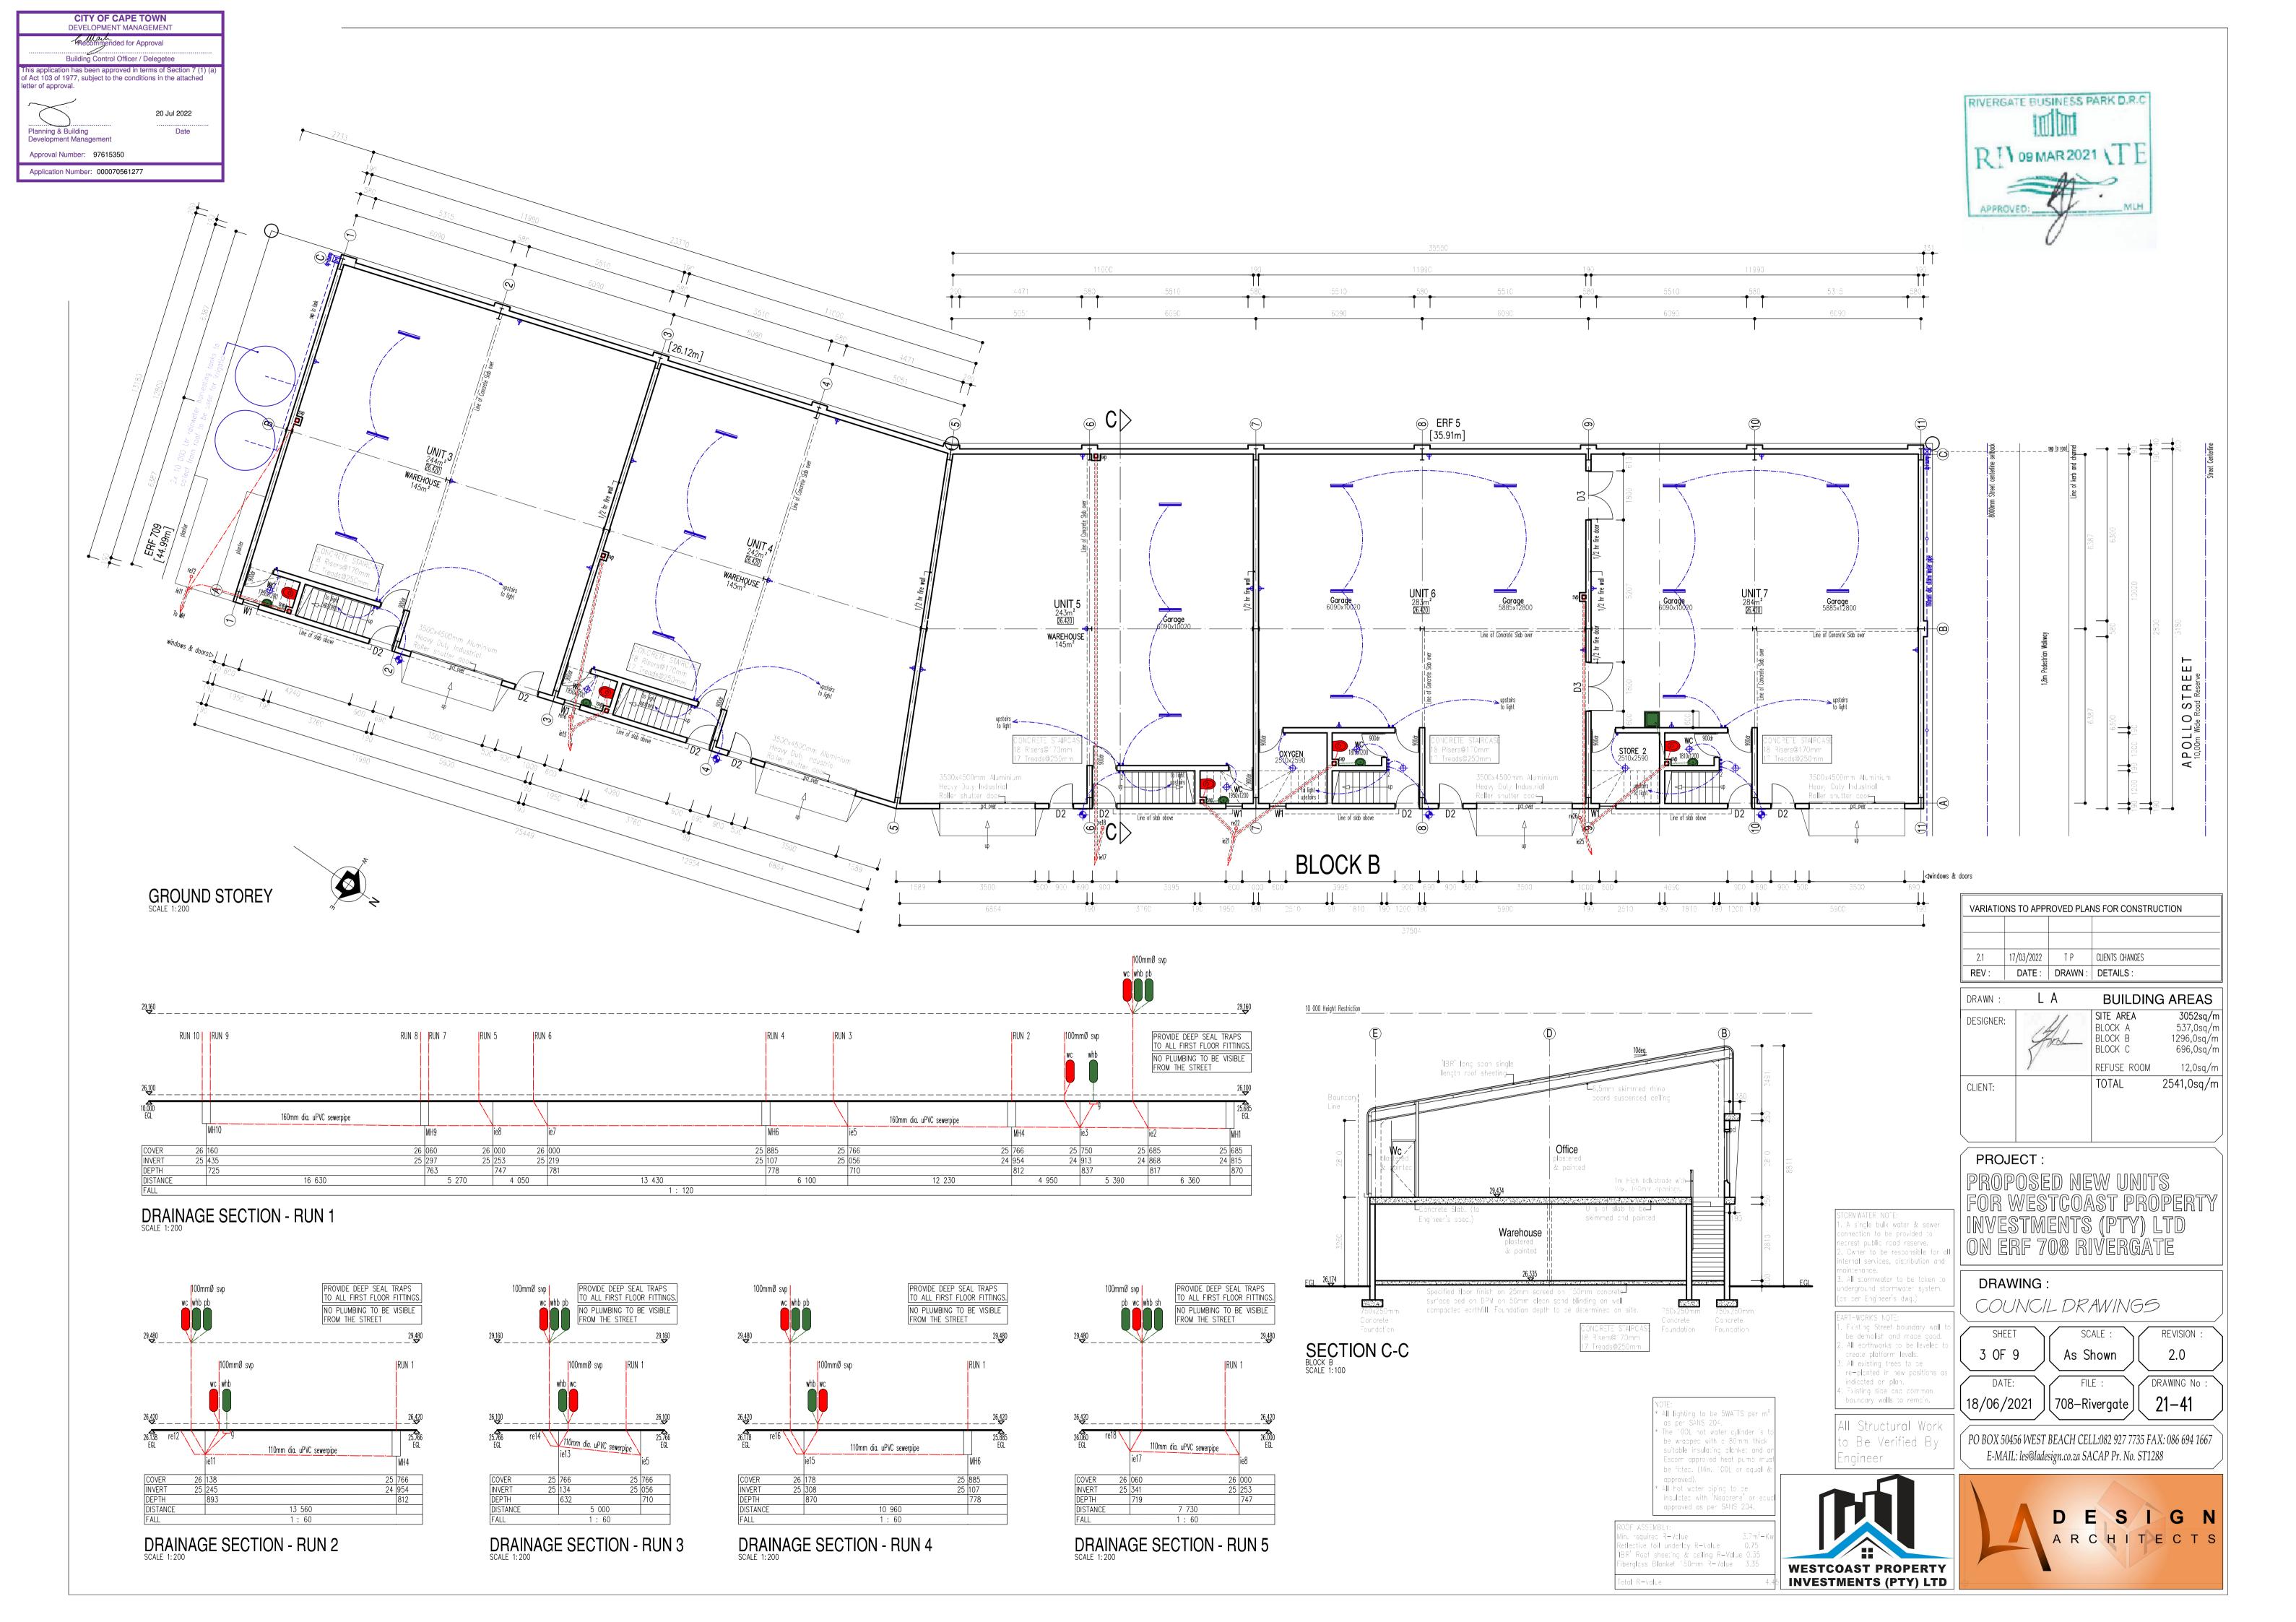


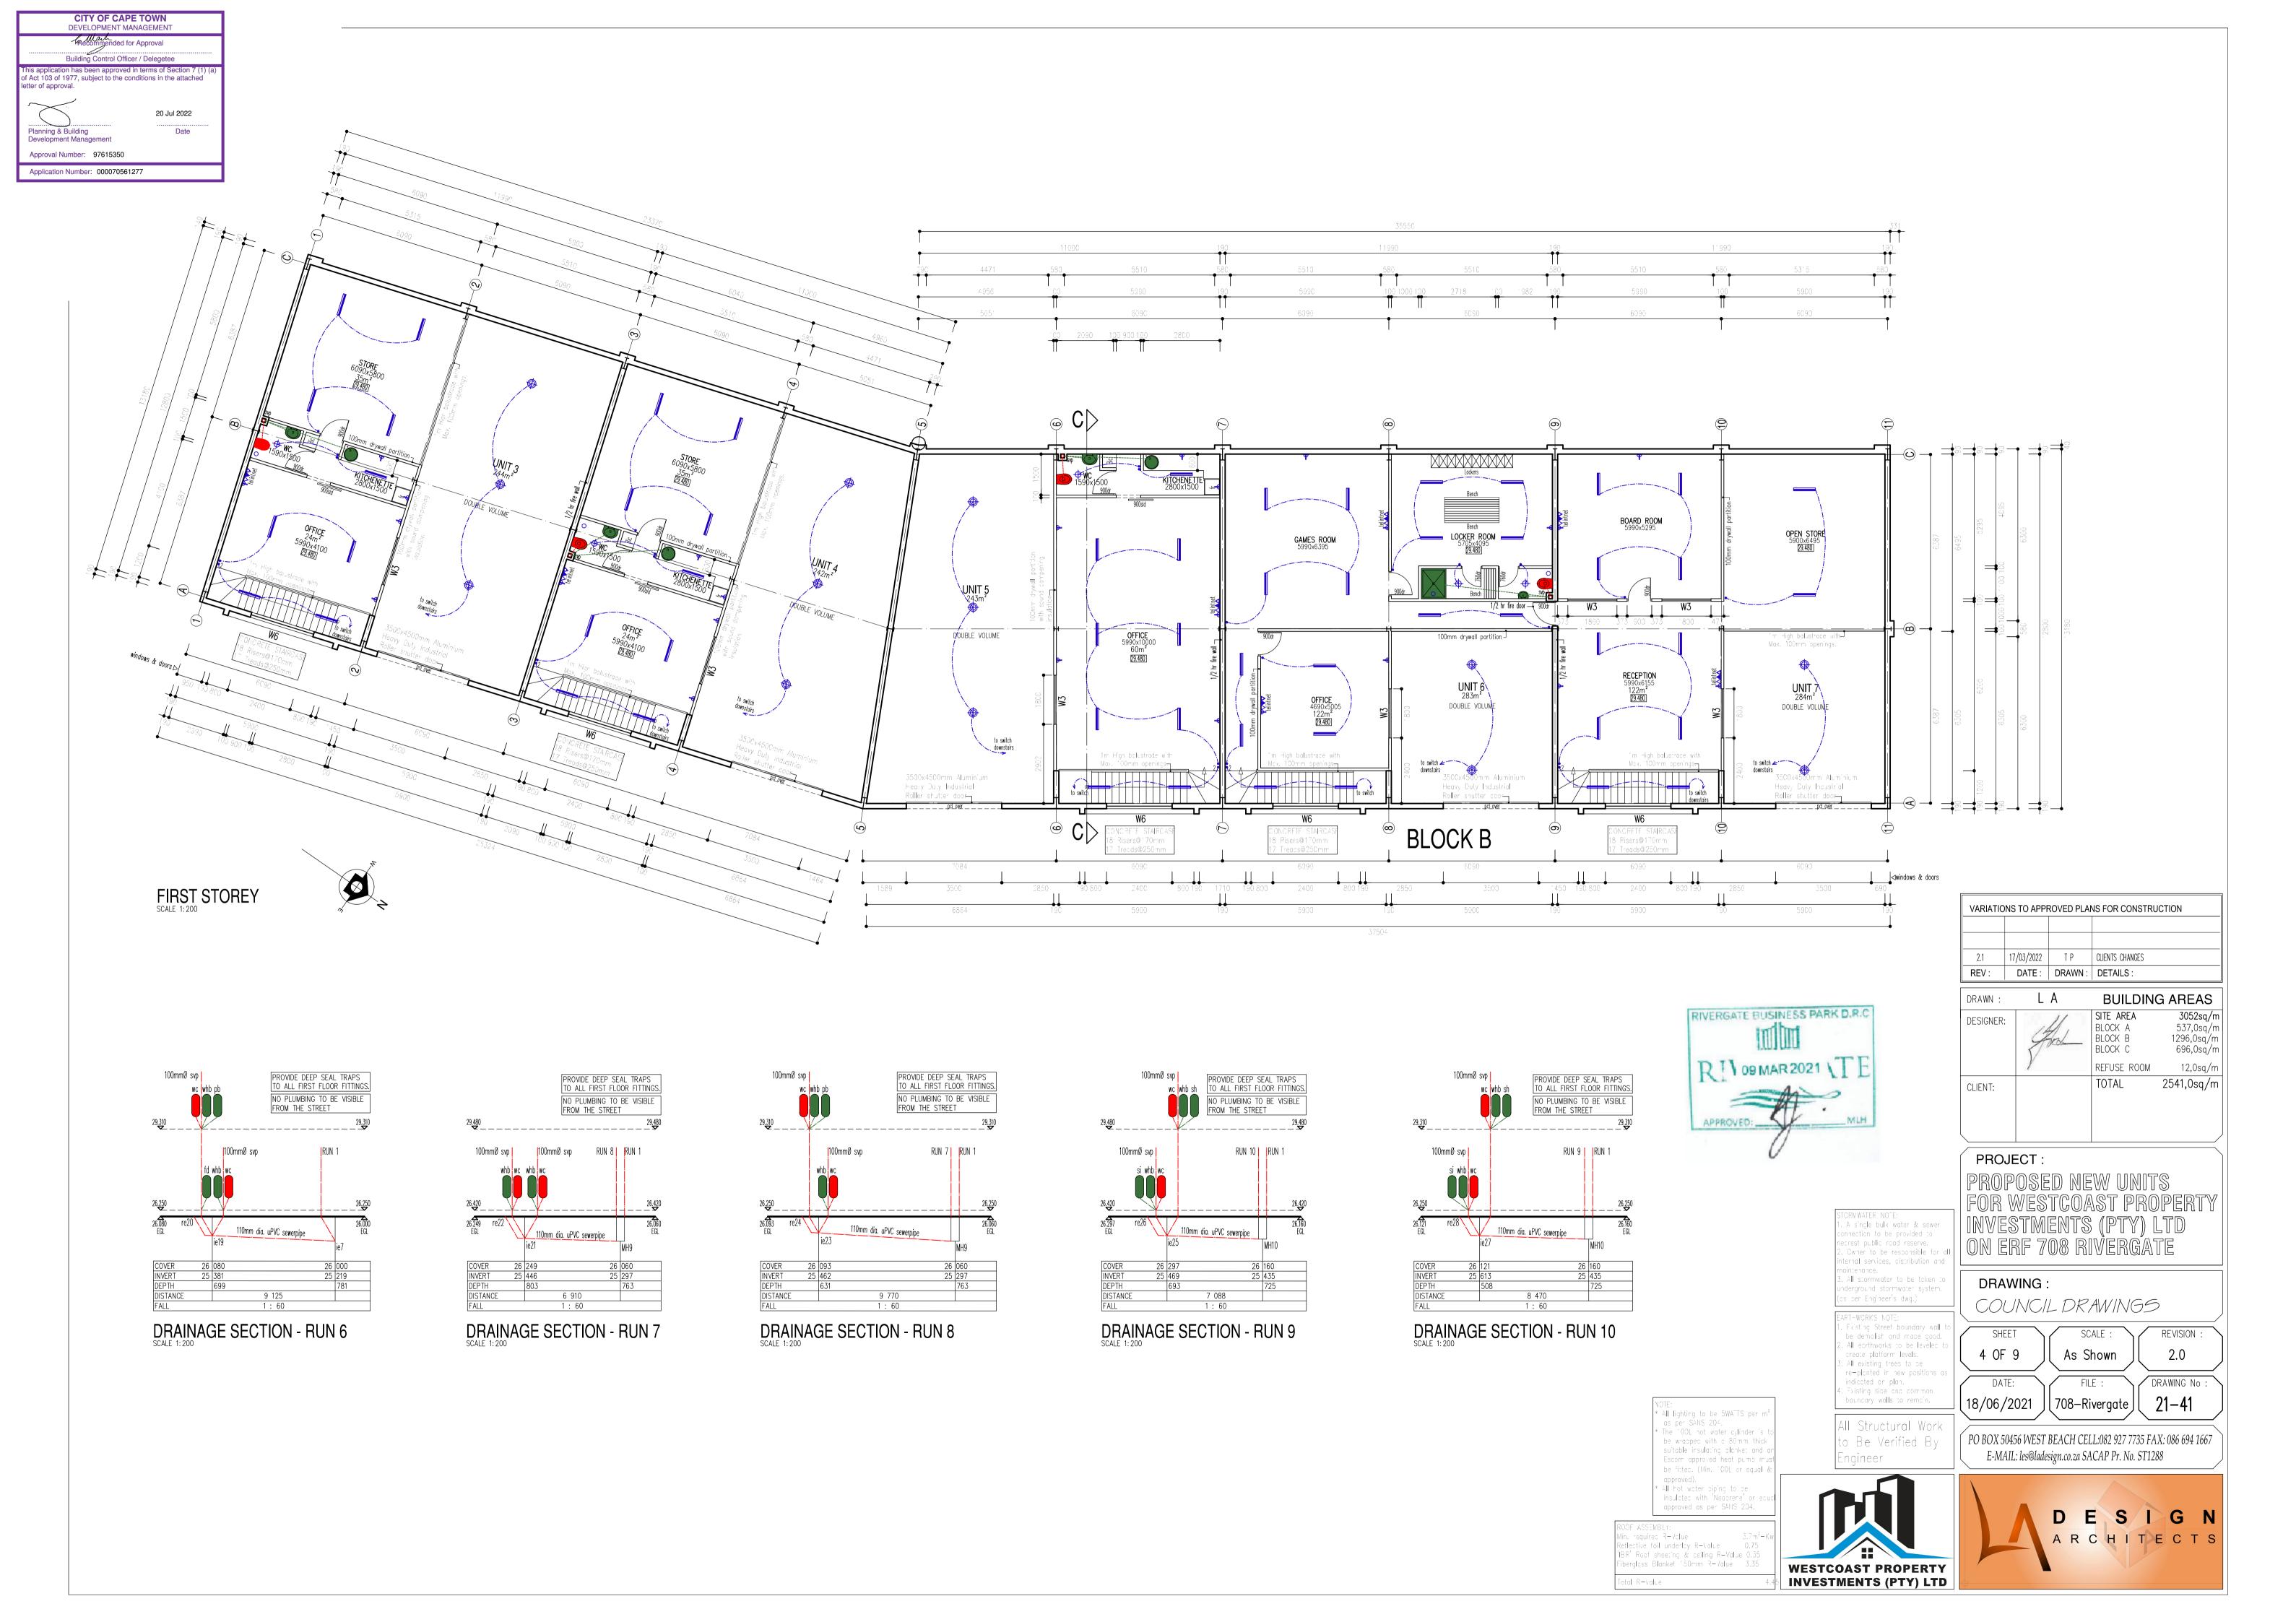




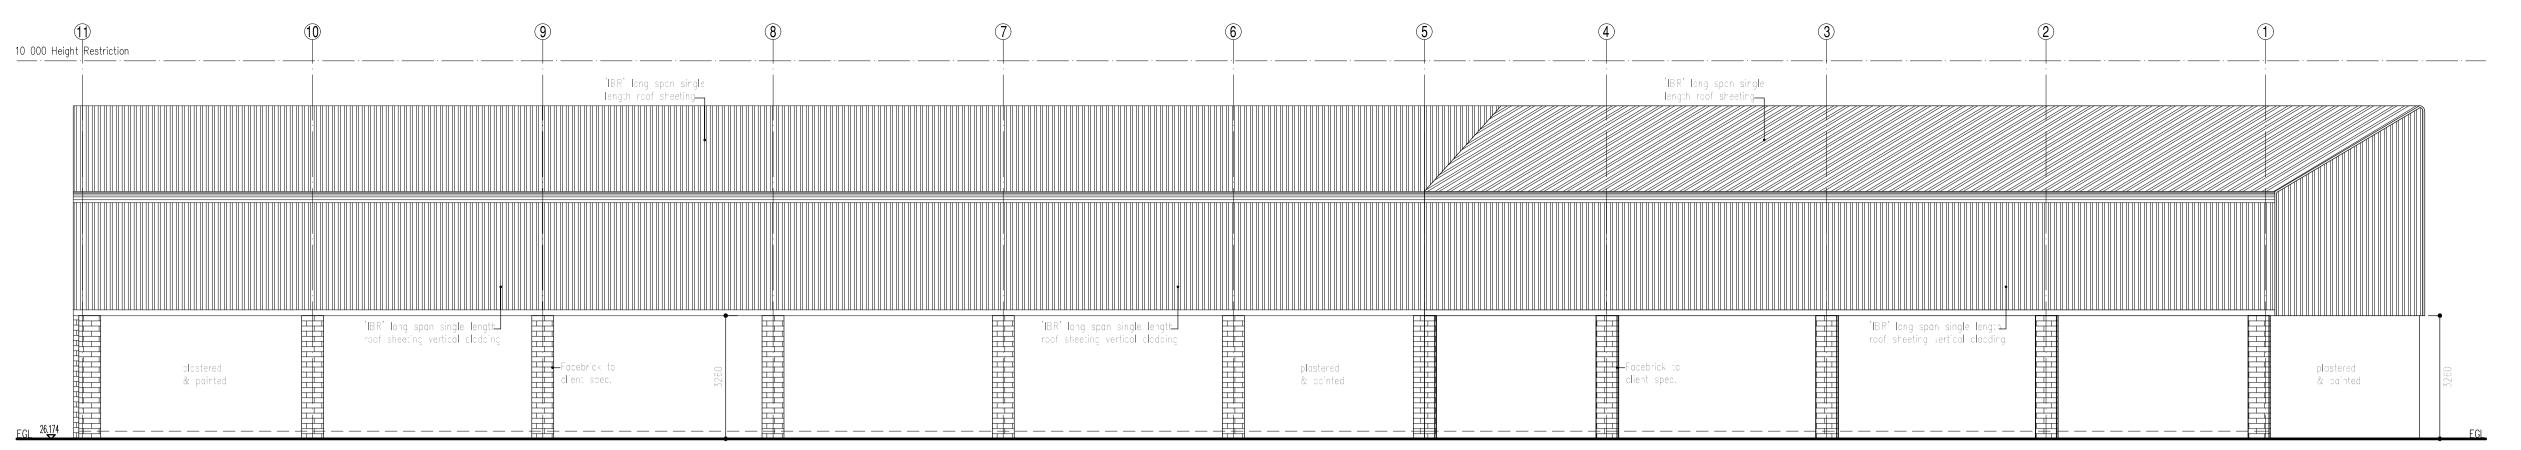


SOUTH WEST ELEVATION BLOCK B SCALE 1: 200

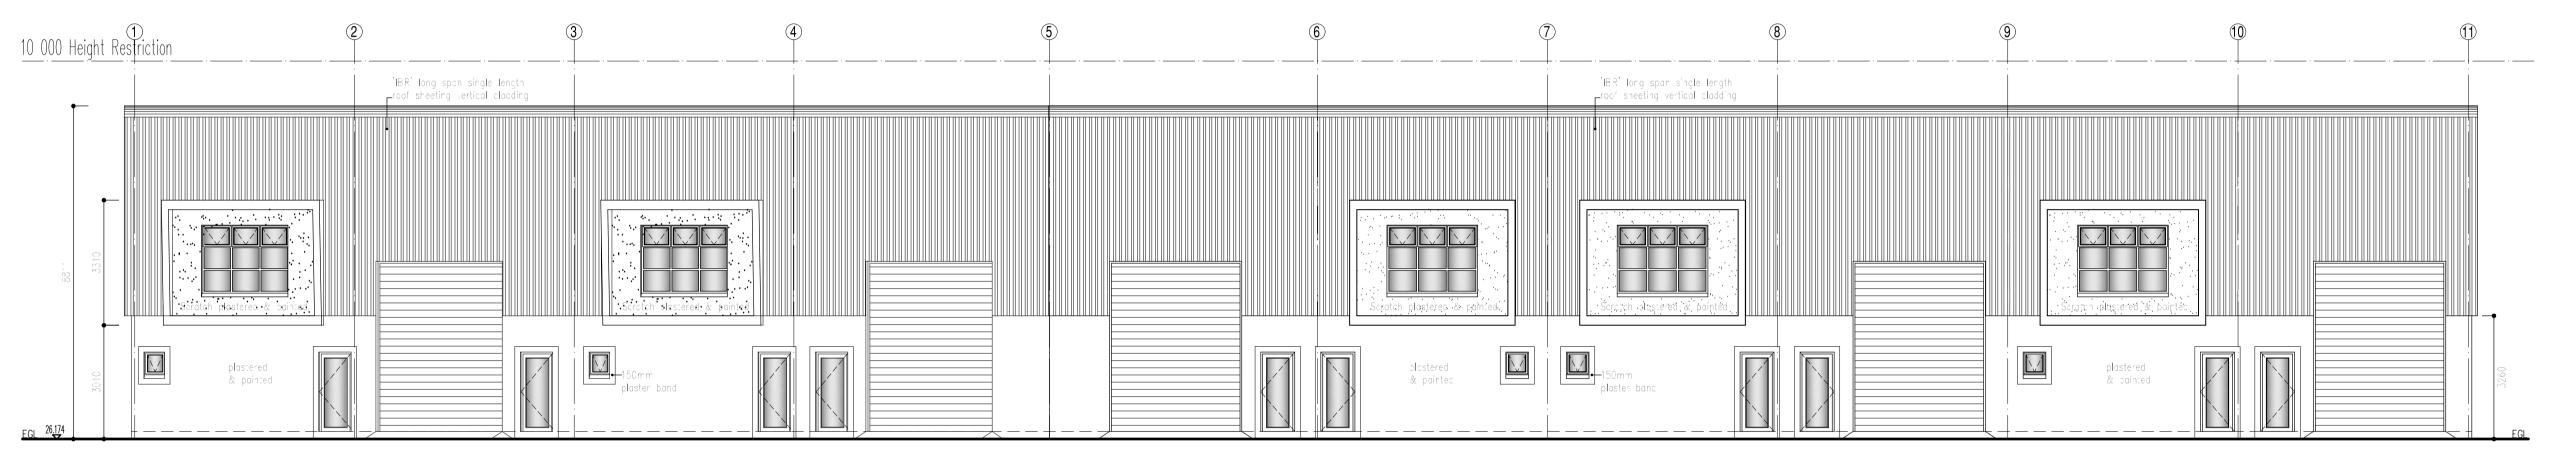

NORTH EAST ELEVATION BLOCK B SCALE 1:200

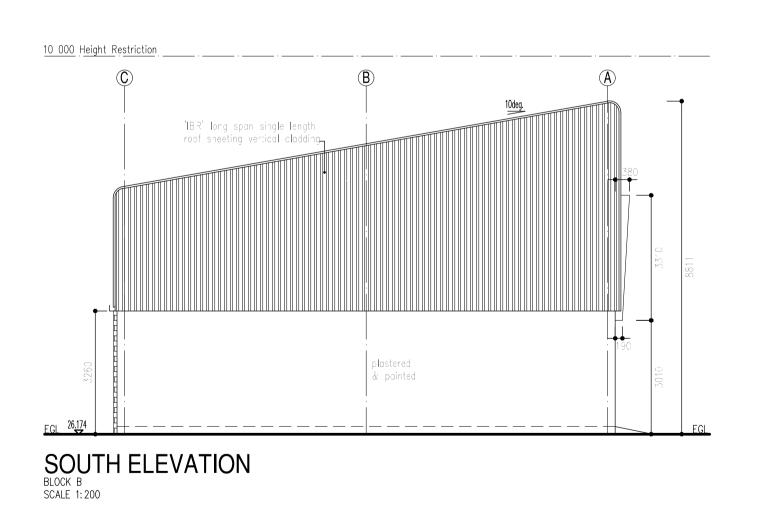

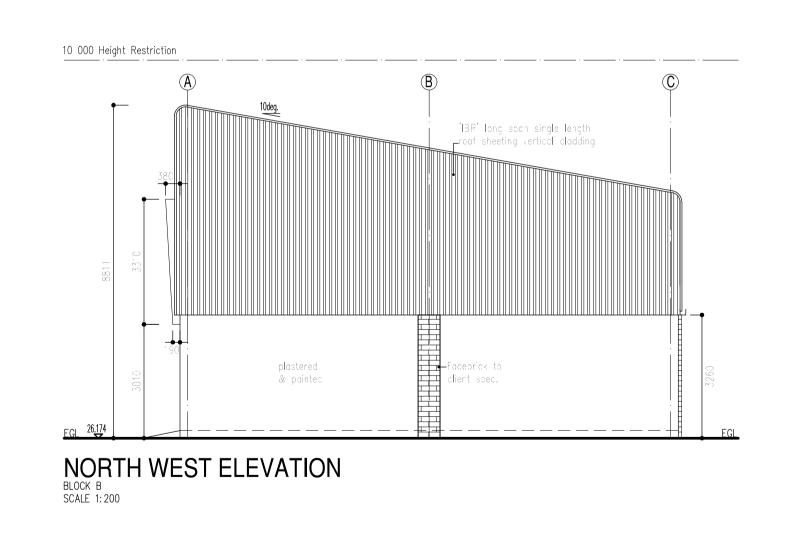



* All lighting to be 5WATTS per m

f The 100L not water cylinder is

be wrapped with a 80mm thick suitable insulating planket and

Escom approved heat pump m be fitted. (Min. 100L or equal & approved).

* All hot water siping to be insulated with 'Neobrene' or e approved as per SANS 204.

as per SANS 204.

n. required R-Value Reflective foil underlay R-Value IBR' Roof sheeting & ceiling R-Value 0 Fiberglass Blanket 150mm R-Value 3.39

Total R-Value

2.1	17/03/2022	ΤP	CLIENTS CHANGES	
REV:	DATE :	DRAWN:	DETAILS :	
DRAWN:	L	A	BUILDIN	G AREAS
DESIGNER:	4		SITE AREA BLOCK A BLOCK B BLOCK C	3052sq/m 537,0sq/m 1296,0sq/m 696,0sq/m
	1		REFUSE ROOM	12,0sq/m
CLIENT:			TOTAL	2541,0sq/m

VARIATIONS TO APPROVED PLANS FOR CONSTRUCTION

PROJECT:

As Shown

FILE :

708-Rivergate

REVISION:

2.0

DRAWING No:

DRAWING:

COUNCIL DRAWINGS ART-WORKS NOTE: . Existing Street boundary wall t SHEET SCALE :

5 OF 9

DATE:

18/06/2021

be demolish and made good. . All earthworks to be leveled t create platform levels. . All existing trees to be re-planted in new positions indicated or plan. Existing side and common bouncary walls to remain.

A single bulk water & sewer onnection to be provided to necrest public road reserve. . Cwher to be responsible for internal services, distribution and 3. All stormwater to be token t


underground stormwater system. os per Engineer's dwg.)

All Structural Work to Be Verified By

PO BOX 50456 WEST BEACH CELL:082 927 7735 FAX: 086 694 1667 E-MAIL: les@ladesign.co.za SACAP Pr. No. ST1288





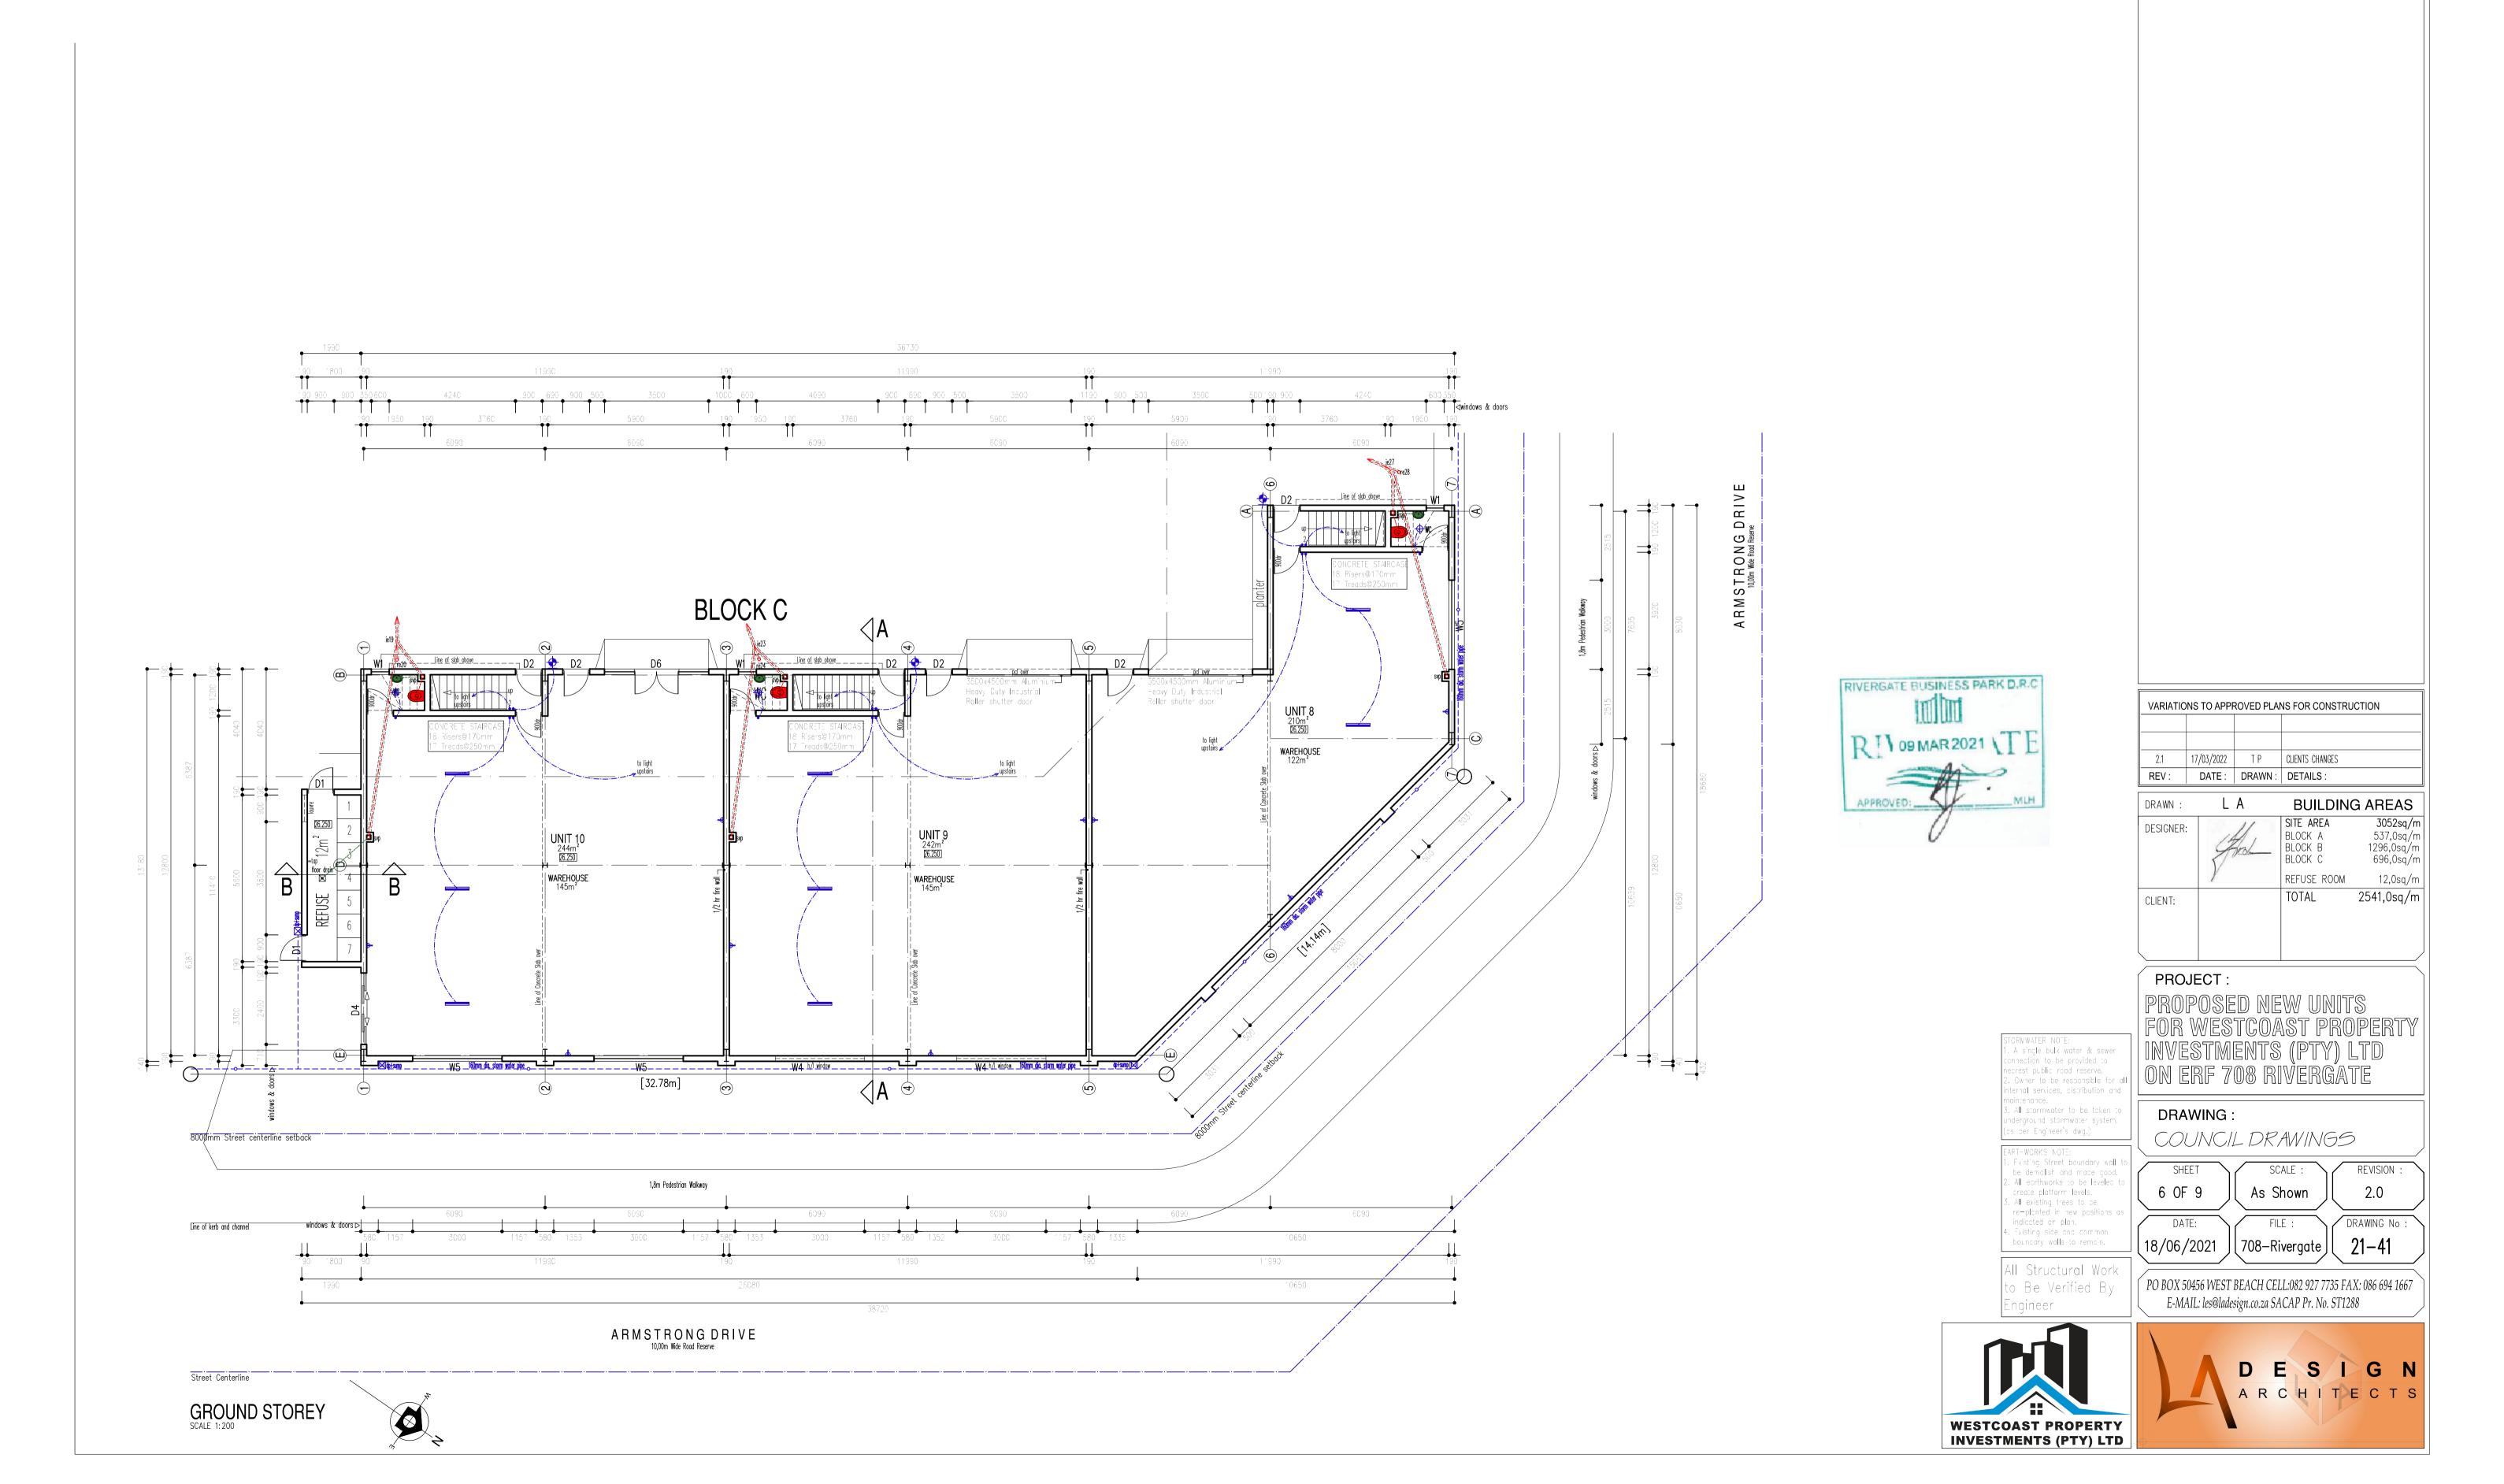

CITY OF CAPE TOWN
DEVELOPMENT MANAGEMENT
RECOMPRISED TO A PROPERTY OF THE PROP

Building Control Officer / Delegetee

20 Jul 2022


This application has been approved in terms of Section 7 (1) (of Act 103 of 1977, subject to the conditions in the attached

letter of approval.


Approval Number: 97615350

Application Number: 000070561277


NOTES

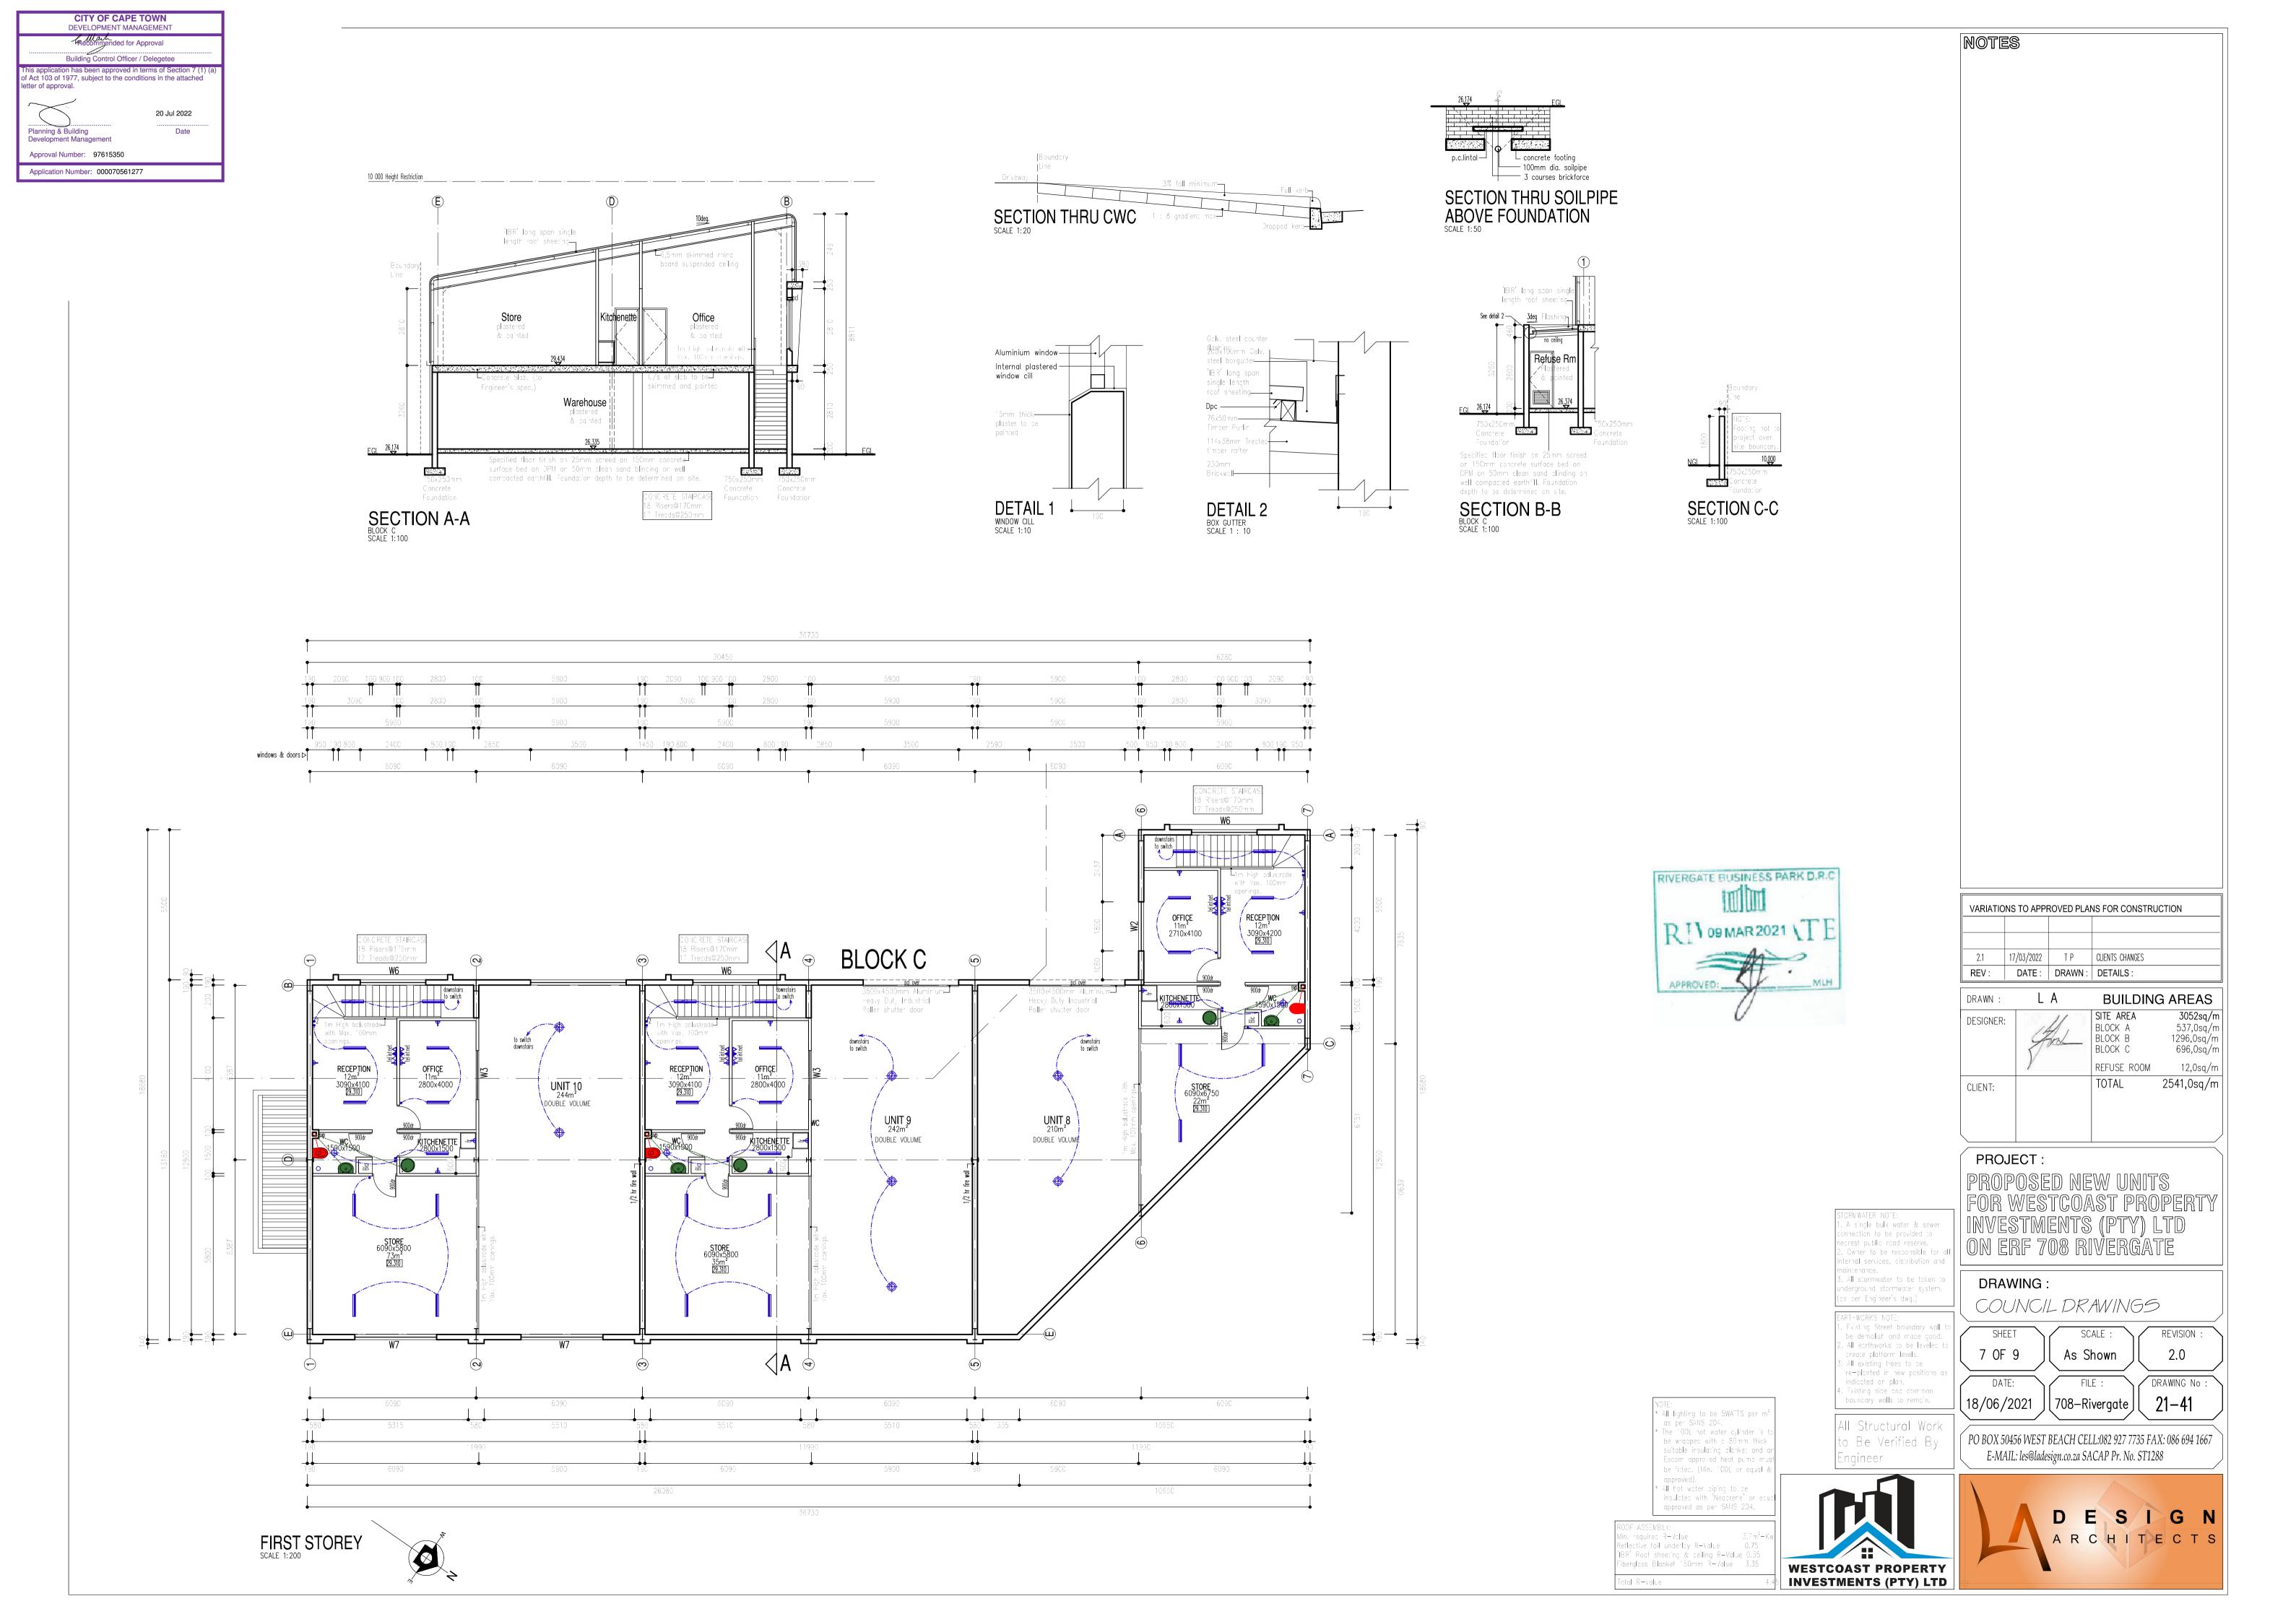



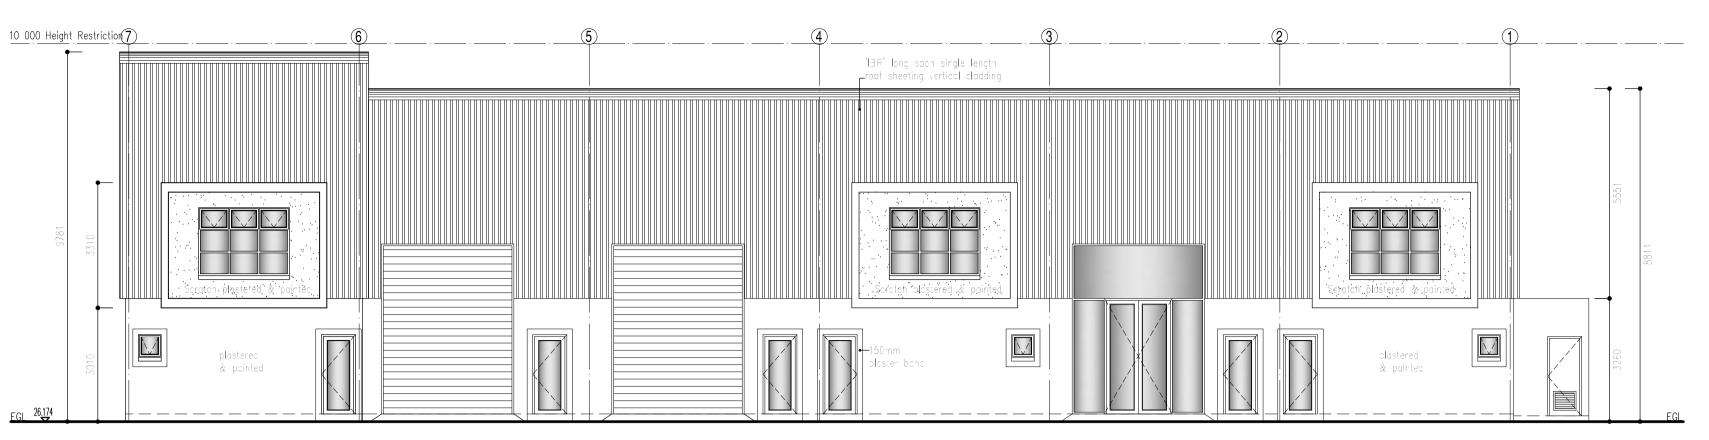



SOUTH WEST ELEVATION BLOCK C SCALE 1:200

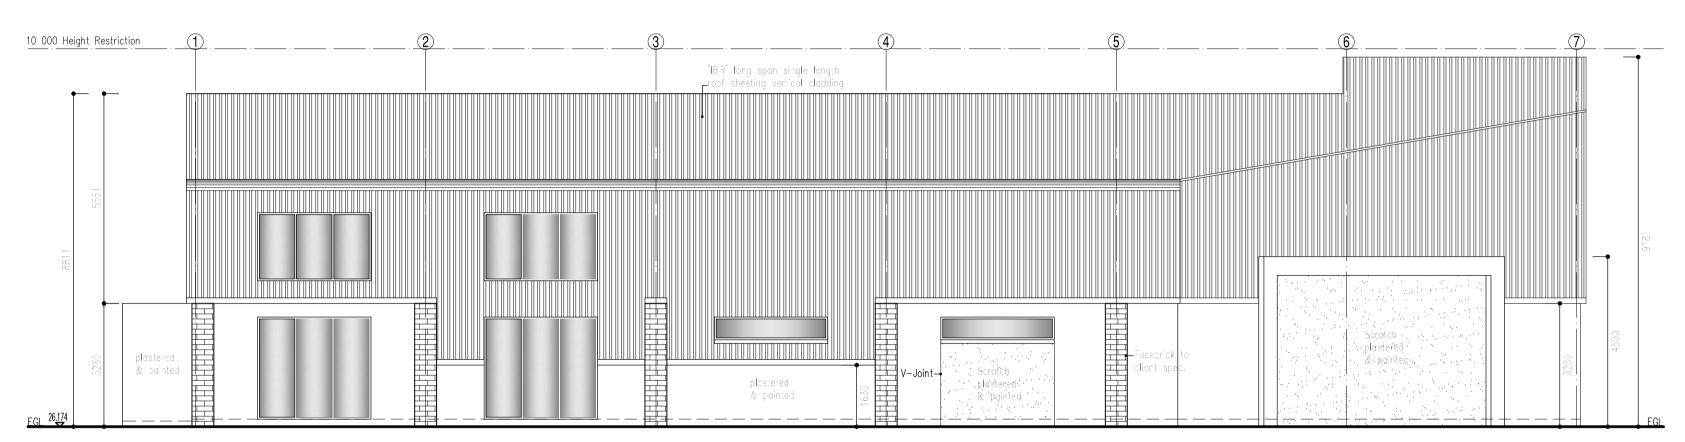



NORTH EAST ELEVATION BLOCK C SCALE 1: 200

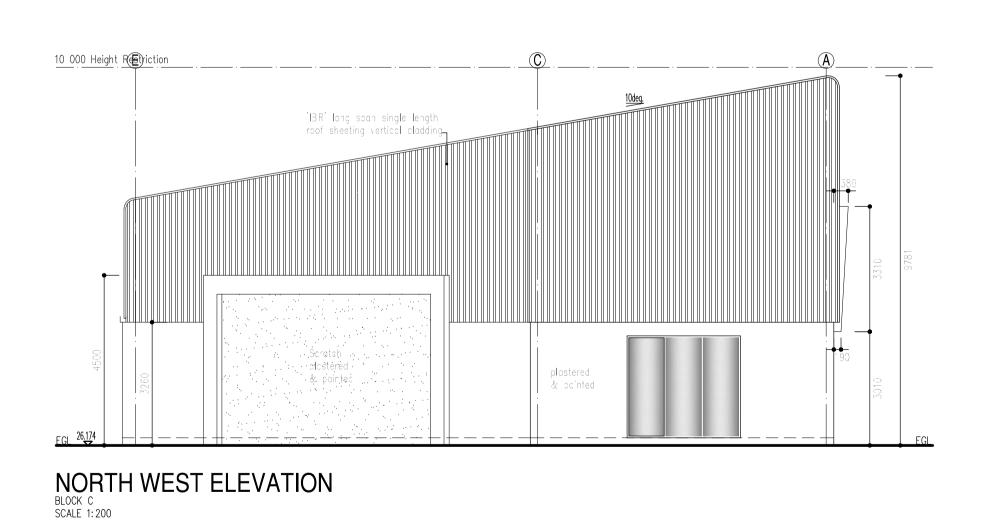

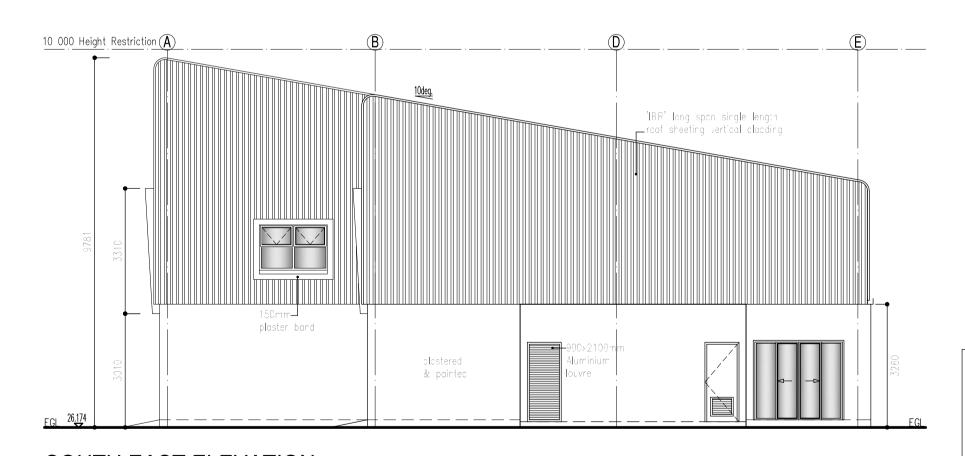

SOUTH EAST ELEVATION
BLOCK C
SCALE 1:200

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A single bulk water & sewer

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underground stormwater system. (as per Engineer's dwg.) í

to Be Verified By

EART-WORKS NOTE



VARIATIONS TO APPROVED PLANS FOR CONSTRUCTION

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DESIGNER:	From	SITE AREA BLOCK A BLOCK B BLOCK C	3052sq/m 537,0sq/m 1296,0sq/m 696,0sq/m
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PROJECT:

NOTES

DRAWING:

COUNCIL DRAWINGS

 Firsting Street boundary wall to be demolish and made good. 	SHEET SCALE : REVISION
All earthworks to be leveled to create platform levels.	8 0F 9
3. All existing trees to be re-planted in new positions as	
indicated or plan. 4. Existing side and common	DATE: FILE : DRAWING No.
bouncary walls to remain.	18/06/2021 708-Rivergate 21-41
All Structural Work	
1	

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