

- Solar panels must be screened from street view. All public spaces as well as neighbors. Geyser for the solar installations be
- situated in the roof void. Pumps to be behind screen walls in
- kitchen yards.



Solar Geyser Note:

- 2.055x100mm Double solar panel


To be installed by specialist acc to SANS 10400

Roof note 1: 3°-30° Roof Pitch, Roof overhang - see Roof plan. Thunderstorm Chromadek Saflok 700 Clip roof sheet ON 76x50mm SA PINE ROOF BATTENS @ 700mm centers on 114x38mm SA Pine Beams @ max 1000mm, ON 114x38mm SA Pine Wall Plate. ISOBOARD 80mm WALL TO WALL INSULATED CEILING (in Bedroom 1-2, Bathroom, Double Garage & Scullery). ISOBOARD 80mm BETWEEN TRUSSES INSULATED

Roof note 2: Reinforced concrete slab roof acc to eng specs & specialist erection. Min 30mm screed with 1:80 fall away from building to Full bore outlet (see detail). Derbigum or Similar approved waterproofing One layer Derbigum SP4 waterproofing membrane, with 75mm side laps and 100mm end laps, sealed to primed surface to falls and crossfalls by "torch-fusion" including | REPORTED TO THIS OFFICE AT ONCE. ANY REVISIONS protection of 50mm thick layer clean 19-25mm crushed stone on Interdek separation layer. Waterproofing to be installed by an CEILING (in Main Bedroom, Main Bathroom, Lounge, Dining & Kitchen) to be installed with a layer of 75mm Fibre Approved Derbigum Contractor under a ten year guarantee. A stone-guard or band of larger stones should be positioned around acoustic insulation laid over the Isoboard to assist with the dampening of weather noise. Confirm and approved by the outlets so as to ensure that the smaller stone is not 'washed' down the outlets. Confirm and approved by engineer.


ELECTRICAL HEATING ELEMENT

INSULATION

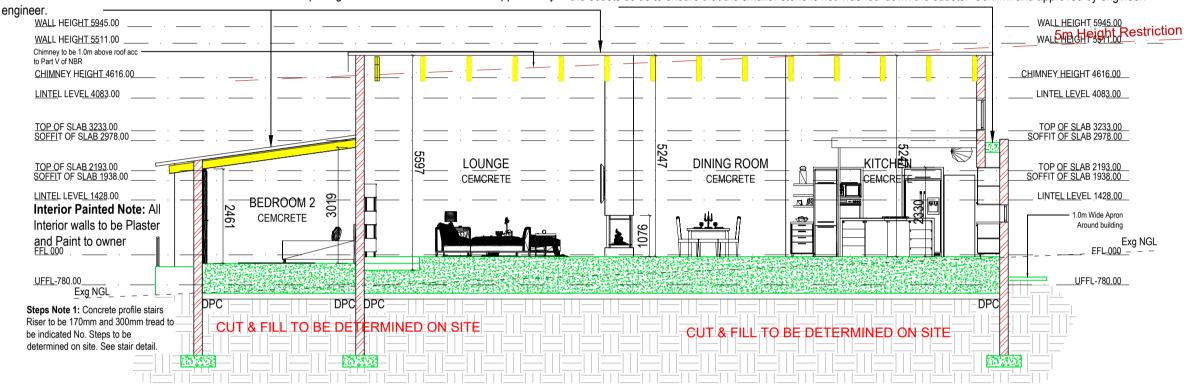

SECTION B-B

NOTE: ALL SLOPES AND LEVELS TO BE CHECKED BY ENG ON SITE SECTION

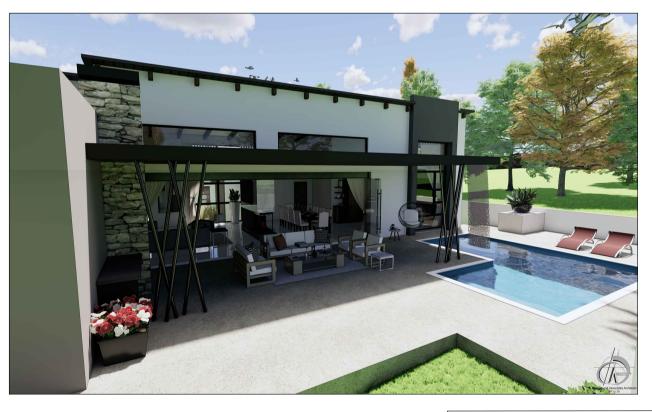




INFORMATION SCHEDULE (ALL COLORS AND CLADDING TO BE APPROVED BY HOA)

COLOUR SCHEME EXTERIOR WALLS: WINDOWS & DOORS: GARAGE DOOR: ROOF COLOUR: CLADDING :

SCHEME

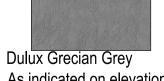

As indicated on elevation/3D

PROPOSED DULUX COLOUR SCHEME



Dulux Co As indicated on elevation/3D

----- NATURAL EARTHLY TONES

- ----- PLASTER & PAINT: NATURAL EARTHY TONES AS BELOW CHARCOAL: POWDER COATED ALUMINIUM --------- CHARCOAL: POWDER COATED ALUMINIUM
- ----- THUNDERSTORM CHROMADEK SAFLOK 700 CLIP ROOF SHEETING ----- MULTI COLOUR SLATE RIVEN CLADDING

PROPOSED DULUX COLOUR PROPOSED DULUX COLOUR PROPOSED PAVING SCHEME



PROPOSED BRICK FINISH

COUNTRY CLASSIC

SATIN COROBRIK

CONCRETE PAVING SLAB CHARCOAL PROPOSED STONE FINISH SAFLOK 700 CLIP

WINDOWS & DOORS



CHARCOAL: POWDER COATED ALUMINIUM


Glazing to be in strict accordance with AAAMSA performance criteria A0, glazed in accordance with SANS 10160, SANS 10137, SANS 10400 (Part N of Section 3) and SANS 1263 Safety glazing is to be in strict accordance with SANS 10400 (Part N) Provide glazing indicators on glass doors and windows as per SANS 10400 (Part N) Glazing from FFL to 1000mm above FFL=safety glass Glass thickness as per

SLIDING DOORS = 6.5mm SAFETY GLASS WITH MARKERS ACCORDING TO S.A.B.S. STANDARDS

ARCHITECTS NOTES

ALL MATERIALS AND CONSTRUCTION MUST COMPLY WITH NATIONAL BUILDING REGULATIONS ACT NO. 103 OF 1997. INCLUDING ALL AMENDMENTS AS WELL AS THE BY-LAWS OF THE LOCAL AUTHORITIES. ALL DIMENSIONS AND LEVELS TO BE CHECKED ON SITE AND NO DRAWINGS MUST BE SCALED. ANY INDISTINCTNESS OR DISCREPANCIES MUST BE IMMEDIATELY POINTED OUT TO THE ARCHITECT FOR RECTIFICATION OR EXPLANATION BEFORE ANY CONSTRUCTION CAN COMMENCE. ALL PLANS ARE PROTECTED BY THE COPYRIGHT ACT NO. 98 OF 1978.

ENERGY EFFICIENT MEASURES TO BE TAKEN B CLIENT. ALL LIGHTS TO BE FITTED WITH ENERGY EFFICIENT FITTINGS. ALL WESTERN WINDOWS TO BE SHADED WITH TREES. WATER SAVING SHOWER HEADS TO BE FITTED. TOILETS TO BE WITH WATER SAVING FLUSH CONTROL. ENERGY EFFICIENCY TO BE TAKEN IN BUILDING TO COMPLY WITH PART XA. MIN 50% OF HOT WATER REQUIRED TO BE SUPPLIED BY HEAT PUMP OR SOLAR. ALL EXPOSED HOT WATER TO INSULATED WITH A "R' VALUE OF 1 ROOF OVERHANG 400mm, ROOF ASSEMBLIES TO ACHIEVE A "R" OF 32 WALLS TO BE 230 BRICK PLASTERED BOTH SIDES WATER TO BE SLOPED AWAY FROM BUILDING. ALL STRUCTURAL WORK TO COMPLY WITH KK5 OF SABS 10400 AND 0401 THE CONTRACTOR ON SITE MUST MAKE SURE THAT THE LEVEL BETWEEN THE HOUSE AND GARAGE IS SO THAT A CAR CAN ENTER THE GARAGE WITH EASE. ALL TIMBER TO BE TREATED ACCORDING TO SABS 1288 STANDARD. ALL FINISHED FLOOR LEVELS ARE TO BE DETERMINED ON SITE AFTER SETTING OUT THE COMPLETED PROJECT. IT IS THE RESPONSIBILITY OF THE OWNER AND OF SUBCONTRACTOR OR CONTRACTOR TO CHECK ALL DIMENSIONS, AREAS, LEVELS AND SITE BOUNDARIES BEFORE COMMENCEMENT OF THE WORK ON SITE ANY DISCREPANCY SHOULD BE REPORTED TO THIS OFFICE AT ONCE. ANY DISCREPANCY BETWEEN PLANS, SPECIFICATION AND QUOTATION SHOULD BE AND OR CHANGES DONE ON SITE MUST BE REPORTED TO THIS OFFICE AT ONCE. NO WORK ON SITE SHALL COMMENCE BEFORE PLANS ARE APPROVED BY THE LOCAL AUTHORITY AND SUCH APPROVAL IS IN THE POSSESSION OF THE CONTRACTOR. IT SHALL BE DETERMINED ON SITE BY THE CONTRACTOR THE GROUND SHALL NEED TO BE INSPECTED BY A ENG TO DETERMINE IF REINFORCING ARE NEEDED IN THE FOUNDATIONS. ANY CONTRACTOR AND OF SUB-CONTRACTOR SHALL AT ALL TIMES MAKE SURE THAT ANY MATERIAL USED ON SITE SHALL BE SUITABLE FOR THE USE THEREOF AND INSTALLED STRICTLY IN ACCORDANCE WITH MANUFACTURERS SPECIFICATION.

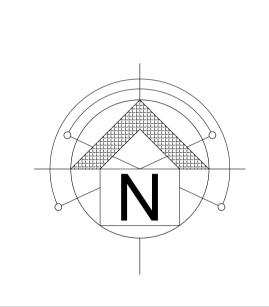

DRAWING STATUS Sketch plan only





domus and Associates Architects (Pty) Ltd @ Office, 67 BRINK STREET OFFICE 25 P.O. BOX 1360, RUSTENBURG TEL: 014 592 1960 FAX: 0866177275


PROJECT:

New Proposed House for Mr. & Mrs. Cussons on Erf 2228, Blue Wildebeest Street Schoongezight Estate, Cashan Ext 7 Rustenburg


DRAWING DESCRIPTION:

Sketch plan Site & Floor lavout

SACAP No - 21044	
DRAWN:	SCALE:
Janine	See plan
DATE:	REVISION:
14/06/2022	04
PROJECT NO.:	DRAWING NO.:
222-08	SK102

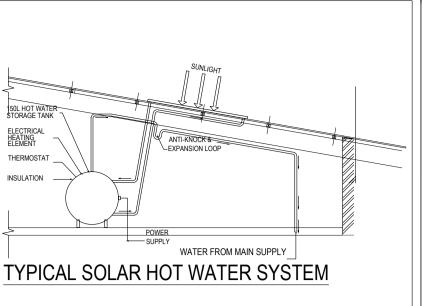

SCALE 1:100

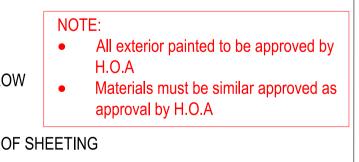



FORMWORK HOLES LIFESPAN - RUSTEAK CONCRETE FINISH